## **RESOLUTION NO. 2023-253**

A RESOLUTION OF THE CITY COUNCIL OF THE CITY OF ELK GROVE FINDING THE ELK GROVE LIBRARY RELOCATION PROJECT EXEMPT FROM CEQA UNDER SECTION 15301 (EXISTING FACILITIES) AND APPROVE A CIP DESIGN REVIEW FOR THE ELK GROVE LIBRARY RELOCATION PROJECT (WFC046) (9260 ELK GROVE BOULEVARD, APN 134-0050-001)

- **WHEREAS**, the City of Elk Grove (City) is a member of the Sacramento Public Library Authority (SPL), a Joint Powers Authority (JPA); and
- **WHEREAS**, under the terms of the SPL JPA, each local agency is responsible for providing the physical space necessary for public libraries within its jurisdiction; and
- **WHEREAS**, in 2006, the City purchased the property at 8900 Elk Grove Boulevard, completed certain improvements, and provided the building to SPL for the Elk Grove Library; and
- **WHEREAS**, in 2018, the City completed a Library and Cultural Arts Center Study (Study), which identified the long-term needs for library and cultural arts facilities in the City; and
- **WHEREAS**, the Study identified that current library facilities are undersized for the current population and that both the Old Town and Franklin branches are not well configured and have poor operational characteristics; and that specifically the existing Elk Grove Library is undersized, has insufficient parking, and is not configured for optimum SPL operations; and
- **WHEREAS**, in 2007, the City approved the Rite Aid Pharmacy Design Review (Project #EG-06-1022), located at 9260 Elk Grove Boulevard, APN 134-0050-001; and
  - WHEREAS, in 2019, the pharmacy ceased operations; and
- **WHEREAS**, in 2021, the City Council authorized purchase of the property for possible use as a relocated Elk Grove Library (the Project); and
- **WHEREAS**, in summer 2021, the City and SPL began conceptual design for a relocated Elk Grove Library at the Project site; and
- **WHEREAS**, the Project site is within the Old Town Special Planning Area (OTSPA) with a classification of Commercial; and
- **WHEREAS**, the OTSPA Commercial listing allows for Commercial-Cultural as permitted uses by right; and
- **WHEREAS**, the Development Services Director has determined that a library is substantially similar to other uses listed as permitted uses in the Commercial-Cultural allowed use listing in the OTSPA and has issued a similar use determination as provided by OTSPA Table 2 Permitted and Conditionally Permitted Land Uses, Footnote 8; and
- **WHEREAS**, based upon the circumstances of the Project as a City Capital Improvement Program (CIP) project, and in keeping with Elk Grove Municipal Code Section 23.16.080 (Design Review), a CIP Design Review is required for the Project, which is subject to City Council action upon recommendation of the Planning Commission; and

**WHEREAS**, the proposed Project is located on real property in the incorporated portions of the City of Elk Grove more particularly described as APN 134-0050-001; and

**WHEREAS**, the City determined that the Project is subject to the California Environmental Quality Act; and

**WHEREAS**, State CEQA Guidelines Section 15301 sets forth an exemption to CEQA for the minor alteration of existing public or private structures, facilities, or equipment involving negligible or no expansion of existing or former use; and

WHEREAS, the Planning Commission held a duly-noticed public hearing on September 25, 2023, as required by law to consider all of the information presented by staff, information presented by the Applicant, and public testimony presented in writing and at the meeting and voted 3-0 (Commissioners Poole and Singha absent) to recommend approval to the City Council; and

**WHEREAS**, the City Council held a duly-noticed public hearing on October 25, 2023, as required by law to consider all of the information presented by staff, information presented by the Applicant, and public testimony presented in writing and at the meeting.

**NOW, THEREFORE, BE IT RESOLVED** that the City Council of the City of Elk Grove hereby find that no further environmental review is required under the California Environmental Quality Act for the Project pursuant to State CEQA Guidelines Section 15301 based upon the following finding:

## **CEQA**

<u>Finding</u>: No further environmental review is required under the California Environmental Quality Act pursuant to State CEQA Guidelines Section 15301.

<u>Evidence</u>: The California Environmental Quality Act (Section 21000, et. seq. of the California Public Resources Code, hereafter CEQA) requires analysis of agency approvals of discretionary "projects." A "project," under CEQA, is defined as "the whole of an action, which has a potential for resulting in either a direct physical change in the environment, or a reasonably foreseeable indirect physical change in the environment." The proposed project is a project under CEQA.

The proposed project is exempt from CEQA under State CEQA Guidelines Section 15301 (Existing Facilities). This exemption applies to the minor alteration of existing public or private structures, facilities, or equipment involving negligible or no expansion of existing or former use. Examples noted in the exemption include, but are not limited to:

- Interior or exterior alterations involving such things as interior partitions, plumbing, and electrical conveyances.
- Additions to existing structures provided that the addition will not result in an increase of more than fifty percent of the floor area of the existing structure or 2,500 square feet, whichever is less, or 10,000 square feet if consistent with the General Plan and not in an environmentally sensitive area.

The proposed Project involves the remodel of an existing 18,147 square-foot building for occupancy by the Elk Grove Library. This use is similar to the prior retail

use, in that the overall intensity and hours of operation are substantially similar to the prior retail use. The proposed site improvements involve interior remodeling of the building, including new partitions, plumbing, and electrical conveyances. Exterior improvements focus on the installation of electrical vehicle charging infrastructure, new patio space, and a "Library of Things" shed. The proposed shed structure measures approximately 96 square feet, which is substantially less than building additions allowed by this exemption. The site has been previously developed and is not within an environmentally sensitive area. Therefore, the Project qualifies for the identified exemption and no further environmental review is required.

**AND**, **BE IT FURTHER RESOLVED**, that the City Council of the City of Elk Grove hereby approves a CIP Design Review for the Project, as described in Exhibit A and illustrated in Exhibit B, subject to the conditions of approval in Exhibit C (all incorporated herein by this reference), based upon the following findings as established in the OTSPA.

## **Design Review**

<u>Finding #1:</u> The proposed project is compatible with the historical character of the community.

<u>Evidence #1:</u> The architecture and design of the proposed Project reflects the historical character of the area and is compatible with the historic character of the community. The building utilizes a collection of brick, stucco, and tile, which are found in other buildings within the neighborhood. The Project has been designed to comply with the standards and guidelines of the OTSPA, including complementary colors and roof forms.

<u>Finding #2:</u> The proposed project is consistent with the objectives of the General Plan, the Zoning Code, and the Old Town Elk Grove Special Planning Area Design Standards and Guidelines.

<u>Evidence #2:</u> The Project is consistent with the objectives of the General Plan, which designates this site as commercial. The Project complies with Land Use Policy LU-6-1, which provides for maintaining and improving the aesthetic quality and architectural diversity of the Old Town historical district. The Project is consistent with the development standards of the Zoning Code and the OTSPA relative to setbacks, height, mass, and overall building form.

<u>Finding #3:</u> The proposed architecture, site design, and landscaping are suitable for the purposes of the building and the site and will enhance the character of the neighborhood and community.

<u>Evidence #3:</u> The architecture of the building is suitable for the purpose of the building. The landscaping has been designed to comply with City standards and will be enhanced and refreshed as part of the Project. New plaza features will integrate to the existing built form and provide additional gathering spaces for library patrons.

<u>Finding #4:</u> The architecture, the character, scale and quality of the design, the relationship with the site and other buildings, building materials, colors, the screening of exterior appurtenances, exterior lighting and signing, and similar elements establish a clear design concept and are compatible with the character of buildings on adjoining and nearby properties.

<u>Evidence #4:</u> The design of the Project establishes a clear design concept and is compatible with nearby properties. For example, adjoining developments to the north and east utilizes similar materials and roof forms. Other developments to the west of the Project within the OTSPA also utilizes these materials and forms. Proposed building colors complement the surrounding area.

<u>Finding #5</u>: The proposed project will not create conflicts with vehicular, bicycle, or pedestrian transportation modes of circulation.

<u>Evidence #5</u>: The Project provides an entry along Elk Grove Boulevard that establishes a pedestrian interface along the street. A bicycle and pedestrian path has been provided across the northern portion of the site along Elk Grove Boulevard. Vehicular access and circulation are provided on site and can accommodate access and circulation for emergency vehicles. Pedestrian pathways across the site are preserved and enhanced with the new plaza spaces.

**AND, BE IT FURTHER RESOLVED**, that the City Council of the City of Elk Grove hereby designates the Project as being subject to the City's Percent for the Arts Program as provided in Resolution No. 2016-226, consistent with the provisions of Section 4, Eligible Funding.

**PASSED AND ADOPTED** by the City Council of the City of Elk Grove this  $25^{\text{th}}$  day of October 2023

BOBBIE SINGH-ALLEN, MAYOR of the CITY OF ELK GROVE

ATTEST:

APPROVED AS TO FORM:

JASON LINDGREN, CITY CLERK

JONATHAN P. HOBBS, CITY ATTORNEY

## **EXHIBIT A: PROJECT DESCRIPTION**

The proposed Project, **the Elk Grove Library Relocation (WEF046)**, involves the remodel of an existing 18,147 square-foot retail building for occupancy as the Elk Grove Library. The existing library at 8900 Elk Grove Boulevard would, upon completion of the proposed improvements, relocate operations to the Project site. The proposed renovations include the addition of various doors and windows to the exterior of the building, repainting of the structure, and various improvements to the Project site, including addition of patio spaces, electric vehicle charging infrastructure, and a shed for storage of a "Library of Things".

## **Design Review**

The following modifications to the existing building and Project site which are illustrated further in Exhibit B, would be made as part of the Project. These improvements are in addition to the interior remodel, described in Exhibit B.

- Replacement of some of the existing display windows with clear windows into the building.
- Addition of doors and windows for additional access and visibility into the structure.
- Creation of a new patio space immediately outside the community room (the Outdoor Meeting Room Patio).
- Addition of an after-hours book locker
- Placement of additional bike racks at the main entrance.
- Addition of a flagpole outside the main entrance.
- Replacement of the fountain structure at the corner of Waterman Road and Elk Grove Boulevard with a focal feature (potentially public art). The exact design of this will be determined at a later date.
- Creation of a patio space in the northeast corner as part of the children's area of the library.
- Addition of an outdoor staff break area along Waterman Road.
- Addition of a Library of Things along the south property line. This structure, which
  would be a shed, will store a variety of equipment that could be checked out from
  the library.
- Addition of a parking space for a Book Mobile.
- Addition of electric vehicle (EV) charging equipment in the parking lot. The site
  would be improved with 10 EV stalls on opening day, with the opportunity to
  expand with an additional 12 stalls (22 stalls in total) as demand increases.
- Cleanup and improvement to the landscaping throughout, including completing maintenance and preventative pruning to the existing trees.
- Repainting the building.
- Replace the roofing along the colonnade shed roofs on the north and west elevations. The replacement will be a standing seam metal roof, with a similar color to the existing one.

## **EXHIBIT B LIBRARY RELOCATION PROJECT PLANS**

# **ELK GROVE LIBRARY RETROFIT**

9260 ELK GROVE BLVD, ELK GROVE CA 95624 **ENTITLEMENT PACKAGE** SEPTEMBER 1, 2023



## PROJECT TEAM

## ARCHITECT:

GROUP 4 ARCHITECTURE RESEARCH + PLANNING: 211 LINDEN AVENUE SOUTH SAN FRANCISCO, CA 94080 T: (650) 871-0709 F: (650) 871-7911

CONTACT: DAWN MARKES

### STRUCTURAL:

SACRAMENTO, CA 95825 T: (650) 394-8869

CONTACT: STEVE R. PATTON

BKF ENGINEER 255 SHORELINE DRIVE, SUITE 200 REDWOOD CITY, CA 94065 T: (650) 482-6300

CONTACT: JONATHAN TANG

### **ELECTRICAL & LIGHTING:**

ATIUM ENGINEERING 3533 YORK LANE SAN RAMON, CA 94582 T: (913) 961-1658

CONTACT: DAVID MAINO

### LANDSCAPE:

CALLANDER ASSOCIATES 12150 TRIBUTARY POINT DRIVE, SUITE 140 GOLD RIVER, CA 95670 T: (916) 985-4366

CONTACT: MELISSA RUTH

## MEP & FIRE PROTECTION:

BLUE FOREST ENGINEERING INC. 3622 KINGSLEY STREET OAKLAND, CA 94610 T: (510) 924-8205

CONTACT: TYLER BRADSHAW

## ACOUSTICS & TELECOM:

SMITH, FAUSE & MCDONALD, INC. 351 8TH STREET SAN FRANCISCO, CA 94103 T: (415) 255-9140

CONTACT: PETER MCDONALD

### PROJECT SCOPE OF WORK:

THIS PROJECT IS THE RENOVATION OF A FORMER PHARMECY BUILDING INTO A LIBRARY, IT IS A FULL INTERIOR RENOVATION WITH ASSOCIATED SITE WORK, AND LIMITED EXTERIOR MODIFICATION TO ADD AND EXPAND OPENINGS.

### LOCATION MAP:



RESEARCH + PLANNING, INC 211 LINDEN AVENUE SO. SAN FRANCISCO C A 9 4 0 8 0 U S A 650.871.0709



Project Arch.	
CA REG.	-
PROJECT:	22583-0
ISSUE	DATE
SD SUBMITTAL	03/03/202
ENTITI EMENT PACKAGE	09/01/202

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SHEET TITLE AND NO

COVER SHEET

A0.0

### SHEET INDEX ENTITLEMENT PACKAGE SHEET NO. SHEET NAME

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L1.1	OUTDOOR MEETING ROOM PATIO
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A2.4-3 ROOF PLAN
A3.1-3 BUILDING ELEVATIONS PRESENTATION BUILDING ELEVATIONS PRESENTATION
BUILDING ELEVATIONS PRESENTATION
ENLARGED WINDOW ELEVATIONS (EXTERIOR)
ENLARGED WINDOW ELEVATIONS (EXTERIOR)
BUILDING SECTIONS A3.1-4

A3.2-1 A3.2-2 A3.4-1 FINISH FLOOR PLAN INTERIOR ELEVATIONS INTERIOR ELEVATIONS INTERIOR ELEVATIONS INTERIOR ELEVATIONS A5.0-1 A5.0-2 A5.0-3 A5.0-4 A5.0-5 A5.0-6 A5.0-7 A6.0-1 INTERIOR ELEVATIONS
INTERIOR ELEVATIONS
INTERIOR ELEVATIONS
INTERIOR ELEVATIONS
REFLECTED CEILING PLAN - FIRST FLOOR LOW

REFLECTED CEILING PLAN - FIRST FLOOR HIGH

A6.0-3 A10.1-1 REFLECTED CEILING PLAN - MEZZANINE FURNITURE PLAN - FIRST FLOOR (N.I.C., FOR REFERENCE ONLY)



ARCHITECTURE RESEARCH + PLANNING, INC

211 LINDEN AVENUE SO. SAN FRANCISCO C A 9 4 0 8 0 U S A 650.871.0709



Project Arch.	-
CA REG.	
PROJECT:	22583-02
ISSUE	DATE
ISSUE SD SUBMITTAL	DATE 03/03/2022

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SHEET TITLE AND NO. SHEET INDEX

A0.1

### ARCHITECTURAL DRAWING ABBREVIATIONS

BLKG. BM. BND/BYND BOT. B.O. B.O.B. B.O.C. B.O.S. B.R.B. BTWN.

B.U.W.P. B.U.R.

CAB. C.B. CEM. C.G. C.J. C.L. CLG. CLO. CLO.

C.M.U.
C.O.
COL.
COMP.
CONC.
CONN.
COND.
CONSTR
CONT.
CORR.
COTR.
CTR.
CTS.
CU.
C.W.

D.A. DBL. DEPT. DET. D.F.

D.F.
DIAG.
DIMG.
DISCONT.
DISP.
DN.
D.O.
D.P.
DR.
D.S.
S.S.P.

D/W DWG. DWR.

(E)

E. E.F. E.J. EL. ELEC.

EMER. ENCL. E.P. EPS. EQ. EQPM. E.W.C.

EXP. EXPO. EXIST. EXT.

F.A. F.D.

BETWEEN

BUILT UP ROOF

CABINET CATCH BASIN CEMENT CERAMIC

CORNER GUARD

CONTROL JOINT CENTERLINE CEILING CLOSET

BEYOND BOTTOM BOTTOM OF BOTTOM OF BEAM BOTTOM OF CONCRETE

BUCKLING RESTRAINT BRACE

MINIMUM CLEAR DIMENSION, F.O.F. TO

CONCRETE MASONRY UNIT

CONCRETE OPENING

COLUMN COMPOSITION

CONNECTION CONNECTION
CONDITION
CONSTRUCTION
CONSTRUCTION
CONTINUOUS
CORRIDOR
COUNTER
CERAMIC TILE

CONCRETE

CENTER

COUNTERSUNK

CONDENSER UNIT

DISABLED ACCESS

DETAIL DRINKING FOUNTAIN

DOUBLE DEPARTMENT

DIAMETER

DIAGONAL

DIMENSION

DIMENSION DISCONTINUOUS DISPENSER DOWN DOOR OPENINGS DIMENSION POINT

DOWNSPOUT DRY STANDPIPE

DISHWASHER

DRAWING DRAWER

EXISTING

EXHAUST FAN

ELEVATION ELECTRICAL

EMERGENCY

EXPOSED

EXISTING EXTERIOR

EXPANSION JOINT

EMERGENCY ENCLOSURE EDGE OF PAVEMENT EXPANDED POLYSTYRENE EQUAL

EQUIPMENT ELECTRIC WATER COOLER

EXPANSION, EXPANDED

CURTAIN WALL OR CUSTOM WOOD

BUILT UP WATERPROOFING

BOTTOM OF STEEL

GA. GALV. G.B. GL. GND. GR. GYP. G.W.B.

HB. HDWD. HDWE. H.M. HORIZ. H.P. HR. HT.

HVAC

J. J.B. JAN. JNT. JST. JT.

KIT.

LAM. LAV. LOC. L.F. L.P. L.T.

MACH. MAX. MECH.

MEMB MET.

MFG. MFR. MIN. MIR. MISC. M.R. M.O. MSNRY M.T MTD.

MTG.

(N) N

N.A. N.I.C. NO. or #

NOM. N.T.S.

O. O.A. O.C. O.D. O.F.C.I O.H.

OPP. OPP. O.R.D. O.R.S.

0.

GROUND

GRADE

GAUGE GALLON GALVANIZED GRAB BAR GLASS OR GRIDLINE

GYPSUM GYPSUM WALL BOARD

HEATING VENTUATING & AIR CONDITIONING

HOSE BIBB HARDWOOD HARDWARE HOLLOW METAL

HORIZONTAL HIGH POINT

INSIDE DIAMETER

INSULATION INTERIOR

JUNCTION

IOINT

JOIST

KITCHEN

LAMINATE

LAVATORY

LOCATION

LIGHT

MACHINE

LINEAR FEET LOW POINT

MACHINE MAXIMUM MECHANICAL MEMBRANE METAL

MANUFACTURER

MANUFACTURER

MISCELLANEOUS MOISTURE RESISTANT MASONRY OPENING

MASONRY METAL THRESHOLD

NEW NORTH NOT APPLICABLE NOT IN CONTRACT NUMBER

NOMINAL NOT TO SCALE

OUTSIDE

OVER OVERALL ON CENTER

OPENING

OPPOSITE

OPPOSITE HAND OFFICE

OVERFLOW ROOF DRAIN OVERFLOW ROOF SCUPPER

OUTSIDE DIAMETER OWNER FURNISHED CONTRACTOR INSTALLED

MANHOLE MINIMUM

MOUNTING

JUNCTION BOX JANITOR

HOUR HEIGHT

ALCHILL	CIUNAL DRAWING ADDREVIATIO	ino.					
A.B.	ANCHOR BOLT	FDN.	FOUNDATION	P.C.	PORTI AND CEMENT	W.C.	WATER CLOSET
ABV.	ABOVE	F.E.	FIRE EXTINGUISHER	PHEN	PHENOLIC	WD.	WOOD
A.C.	ASPHALT CONCRETE PAVING	F.E.C.	FIRE EXTINGUISHER CABINET	PL.	PLATE	W.H.	WATER HEATER
A.C.T.	ACOUSTIC CEILING TILE	F.F.	FINISHED FLOOR	P.L.	PROPERTY LINE	WIND.	WINDOW
ACOUS.	ACOUSTICAL	F.F.E.	FINISHED FLOOR ELEVATION	PIAM	PLASTIC LAMINATE	W/O	WITHOUT
A.D.	AREA DRAIN	F.G.	FIXED GLASS	PLAS.	PLASTER	WP.	WATERPROOF OR WATERPROOFING
ADD.	ADDITIONAL	F.H.C.S.	FLAT HEAD COUNTERSUNK	PLUMB.	PLUMBING	W.P.	WORK POINT
ADJ.	ADJUSTABLE	FIN.	FINISH	PLYWD.	PLYWOOD	WSCT.	WAINSCOT
A.E.S.S.	ARCHITECTURAL EXPOSED STRUCTURAL	FL.	FLOOR	PR.	PAIR	WT.	WEIGHT
	STEEL	FIXT.	FIXTURE	PRCST.	PRECAST	****	WEIGHT
A.F.F.	ABOVE FINISH FLOOR	FLASH.	FLASHING	PREFIN.	PREFINISHED	8	AND
AGGR.	AGGREGATE	FLUOR.	FLUORESCENT	PT.	POINT	Z	ANGLE
ALT.	ALTERNATE	F.O.	FACE OF	PTD.	PAINTED	@	AT
AL.	ALUMINUM	F.O.C.	FACE OF CONCRETE	P.T.D.	PAPER TOWEL DISPENSER	Č	CENTERLINE
ALUM.	ALUMINUM	F.O.F.	FACE OF FINISH	P.T.D./RE	COMBINATION PAPER TOWEL DISPENSER &	DIA.	DIAMETER
APPROX.	APPROXIMATE	F.O.M.	FACE OF MASONRY		RECEPTACLE	PERP.	PERPENDICULAR
ARCH.	ARCHITECTURAL, ARCHITECT	F.O.S.	FACE OF STUD	P.V.C.	POLYVINYLCHLORIDE	DN.	SLOPE DOWN/STAIR DOWN
ASPH.	ASPHALT	F.R.P.	FIBERGLASS REINFORCED PANEL				
		FRPF.	FIREPROOF	(R)	REMOVE EXISTING		
BD.	BOARD	FRPG.	FIREPROOFING	(RĹ)	RELOCATE EXISTING		
BET.	BETWEEN	F.S.	FOOD SERVICE	R.	RISER		
BIT.	BITUMEN	FT.	FOOT OR FEET	RAD.	RADIUS		
BLDG.	BUILDING	FTG.	FOOTING	R.D.	ROOF DRAIN		
BLK.	BLOCK	FURR.	FURRING	REF.	REFERENCE		
BLKG.	BLOCKING			REFL.	REFLECTED		
BM.	BEAM	GA.	GAUGE	REFR.	REFRIGERATOR		
BND/BYND	BEYOND	GAL.	GALLON	REINF.	REINFORCED OR REINFORCING		
BOT.	BOTTOM	GALV.	GALVANIZED	REQ.	REQUIRED		
B.O.	BOTTOM OF PEAM	G.B.	GRAB BAR	R.E.S.	RESILIENT EDGE STRIP	ADCUITECTUDAL	DRAWING TITLE ARRESVIAT

RESIL. RGTR. RM. R.O. RV. R.W.L.

S. S.A.D

SHWR. SHT. SHTG. SIM.

SK. S.N.D. S.N.R. SOF. SPEC. SQ. S.S. STA. STD. STL. STOR. STRL. STOR. STRL. STUCT SUSP. SYM.

T.
T.B.
T.C.
TEL.
TEMP.
TEXT.
THK.
THRES.
T.P.
T.P.D.
T.S.
T.O.
T.O.B.

T.O.C. T.O.P. T.O.R. T.O.S. T.O.W TYP.

UNF. U.O.N. UR.

V.C.T. VERT VEST V.I.F. V.T.R.

SEE ARCHITECTURAL DOCUMENTS

SEE CIVIL DOCUMENTS SEE ELECTRICAL DOCUMENTS

SEE ELECTRICAL DOCUMENTS SEE GRAPHIC DOCUMENTS SEE LANDSCAPE DOCUMENTS SEE MECHANICAL DOCUMENTS SEE PLUMBING DOCUMENTS

SEE STRUCTURAL DOCUMENTS

SINK SANITARY NAPKIN DISPENSER

SANITARY NAPKIN DISPENSER SANITARY NAPKIN RECEPTACLE SOFFIT

SOLID CORE SEAT COVER DISPENSER

SCHEDULE

SECTION SHOWER

SHEATHING SIMILAR

SPECIFICATION

SQUARE STAINLESS STEEL STATION

STANDARD STEEL STORAGE

SUSPENDED SYMMETRICAL

TOWEL BAR TOP OF CURB TELEPHONE TEMPERED TEXTURE

THICK THRESHOLD

TUBE STEEL

TOP OF TOP OF BEAM

TOP OF WALL

TYPICAL

UNFINISHED

VENT TO ROOF

WEST

TOP OF PAVEMENT TOILET PAPER DISPENSER

UNLESS OTHERWISE NOTED

VINYL COMPOSITE TILE VERTICAL VESTIBULE VERIFY IN FIELD

TOP OF BLAM
TOP OF CURB OR TOP OF CONCRETE
TOP OF PARAPET
TOP OF ROOF
TOP OF STEEL

TREAD

SHEET

SOAP DISPENS SQUARE FOOT SHELF SHELVES

SEE TELECOM AND AV DOCUMENTS

REGISTER ROOM ROUGH OPENING

SOUTH

ROOF VENT RAIN WATER LEADER

#### ARCHITECTURAL DRAWING TITLE ABBREVIATIONS

NOTE: TO DE

DA DR EQ


BREVIATIONS BELOW APPLY AWING TITLES.		BBREVIATIONS BELOW APPLY TO EVATION DRAWING TITLES.
INTERIOR EXTERIOR	(E)	EXISTING
	CP	CEILING PLAN
BICYCLE CANOPY	CPE	ENLARGED CEILING PLAN
CEILING	EE	ENLARGED ELEVATION
CASEWORK	EL	ELEVATION
DISABLED ACCESS COMPLIANCE	FP	FLOOR PLAN
DOOR	FPE	ENLARGED FLOOR PLAN
EQUIPMENT	FPR	REFERENCE FLOOR PLAN
FLOOR	GR	GRID PLAN
WINDOW	RCP	REFLECTED CEILING PLAN
METAL PANEL	RP	ROOF PLAN
PENETRATIONS	RPR	REFERENCE ROOF PLAN
ROOF	SP	SITE PLAN
SIGNAGE		
SITE		
VERTICAL CIRCULATION		

## WINDOW SCHEDULE WALL TYPE LEGEND

EXISTING WALL, TO REMAIN
EXISTING WALL, TO BE DEMOLISHED
NEW WALL

WATEPROOFING BELOW GRADE

### ARCHITECTURAL DRAWING SYMBOLS LEGEND

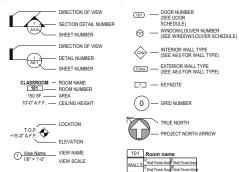

RASE

Base Finish-SouthBase Finish



CAREG

**ELK GROVE** 

LIBRARY RETROFIT

9260 ELK GROVE BLVD

**ELK GROVE** 

CA 95624

ARCHITECTURE

RESEARCH + PLANNING, INC 211 LINDEN AVENUE SO. SAN FRANCISCO C A 9 4 0 8 0 U S A 650.871.0709

DRAFT FOR INTERNAL USE ONLY, NOT FOR CONSTRUCTION.

SHEET TITLE AND NO ABBREVIATIONS & LEGEND

A0.2



1 IN- INTERIOR PERSPECTIVES - MARKET PLACE LOOKING WEST 3/4" = 1'.0"



2 IN- INTERIOR PERSPECTIVE - MARKETPLACE LOOKING EAST



A R C H I T E C T U R E R E S E A R C H + PLAN N IN G, IN C 211 LINDEN AVENUE SO. SAN FRANCISCO C A 9 4 0 8 0 U S A 6 5 0 8 7 1 0 7 0 9




Project Arch.	
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PROJECT:	22583-0
ISSUE	DAT
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SD SUBMITTAL	DATI 03/03/202 09/01/202
ISSUE SD SUBMITTAL ENTITLEMENT PACKAGE	03/03/202

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SHEET TITLE AND NO.

INTERIOR
PERSPECTIVES
(FOR REFERENCE
ONLY)

A0.4-7



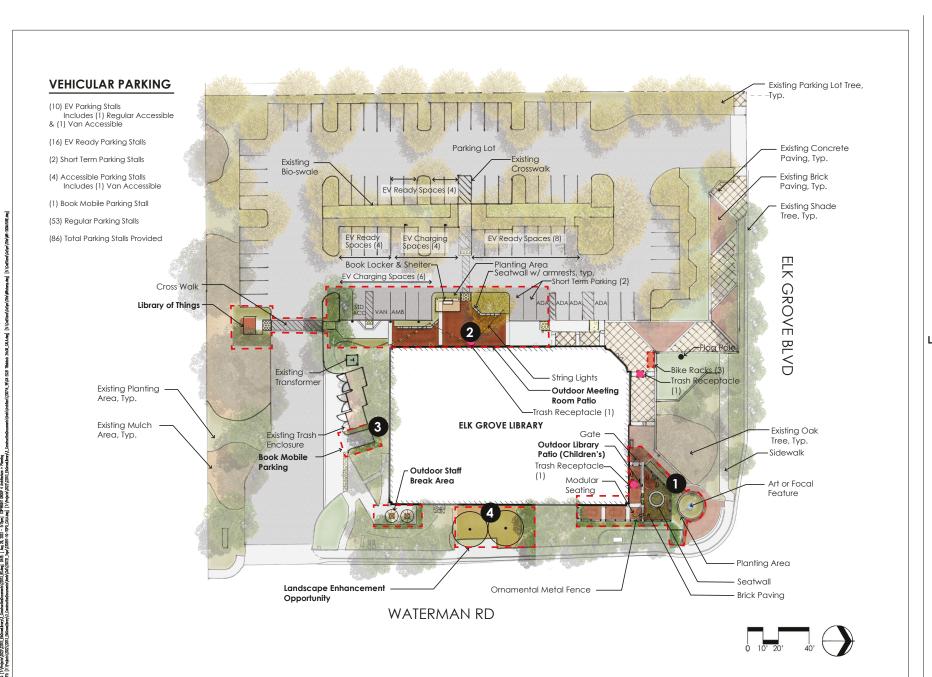

6 R 0 U

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21 LINDEN AVENUE 50. SAN FRANCISCO C A 9 4080 U S A 65 0.871.07 09



12150 Tributary Point Drive, Suite Gold River, CA 95670 T 916.985.4366 www.callanderassociates.com





## ELK GROVE LIBRARY RETROFIT

9260 ELK GROVE BLVD ELK GROVE CA 95624



ISSUE DATE
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ENTILLMENT PACKAGE 6/4/2023
COST ESTIMATING SET 4/1/2028
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SHEET TITLE AND NO. LANDSCAPE CONCEPT PLAN









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SHEET TITLE AND NO. OUTDOOR MEETING ROOM PATIO





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SHEET TITLE AND NO.
OUTDOOR
LIBRARY PATIO &
MISCELLANEOUS

## 1 OUTDOOR LIBRARY PATIO

- Modular & Fixed Seating
- Decorative Seatwall
- Ornamental Fencing
- Brick Patio













- Outdoor Staff Break Area
- Seating w/ Shade
- Library of Things Shed





SEE SHEET L1.0 FOR LANDSCAPE CONCEPT PLAN

## 2 OUTDOOR MEETING ROOM PATIO

- Seatwall
- String Lights
- Enhanced Pavement





## 4 LANDSCAPE ENHANCEMENT OPPORTUNITIES

- Bio-swale Planting
- Street Trees along Waterman Rd
- Low Water Use Grasses and Flowering Shrubs



G+

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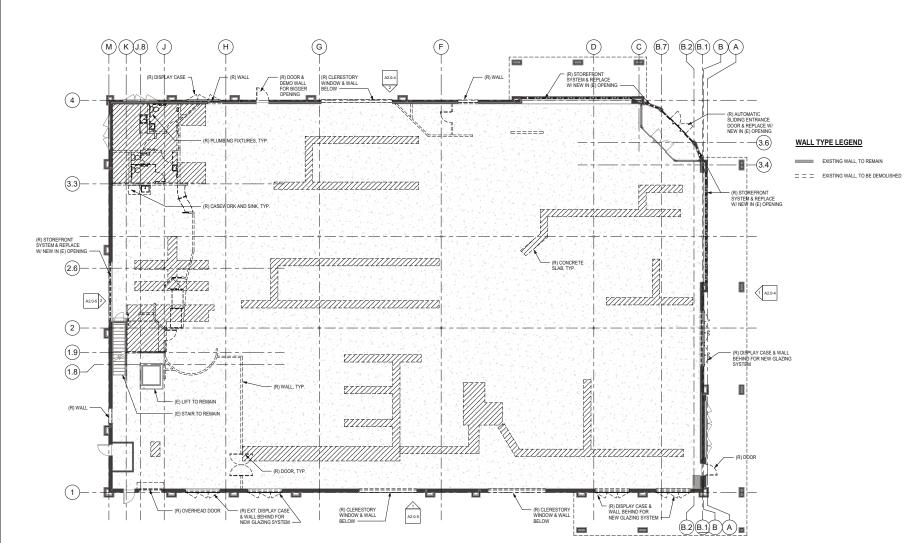


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SHEET TITLE AND NO.
LANDSCAPE
CONCEPT IMAGES

- SEE A0.3-0 FOR GENERAL DEMOLITION NOTES SEE A2.0-4 & A2.0-5 FOR DEMO ELEVATIONS PATCH & REPAIR PLOOR AFTER REMOVAL OF WALLS PATCH & REPAIR WALLS TO REMAIN SEE M.E.P. DRAWINGS FOR UNDERGROUND UTILITIES FOR





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SHEET TITLE AND NO. DEMOLITION FIRST FLOOR PLAN

A2.0-1

(1) (D) FP01- FIRST FLOOR PLAN- DEMOLITION


- SEE A0.3-0 FOR GENERAL DEMOLITION NOTES
  SEE A2.0-4 & A2.0-5 FOR DEMO ELEVATIONS
  PATCH & REPAIR FLOOR AFFER REMOVAL OF WALLS
  PATCH & REPAIR WALLS TO REMAIN
  SEE ME.P. DRAWINGS FOR UNDERGROUND UTILITIES FOR
  TRENCHING



## WALL TYPE LEGEND

EXISTING WALL, TO REMAIN

 $\equiv \ \equiv \ \equiv \$  EXISTING WALL, TO BE DEMOLISHED

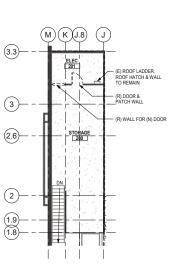

(D) FP02 - MEZZANINE FLOOR PLAN - DEMOLITION



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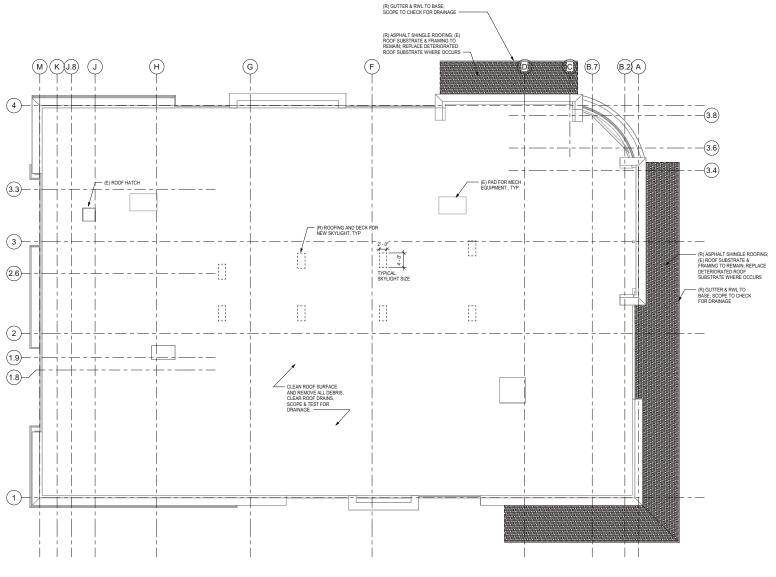



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DAT
03/03/202
09/01/2023


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SHEET TITLE AND NO. DEMOLITION ROOF PLAN

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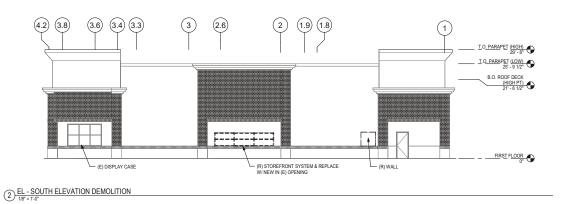





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03/03/202
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DEMOLITION ELEVATIONS

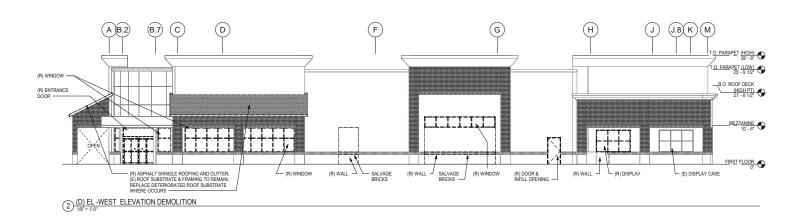

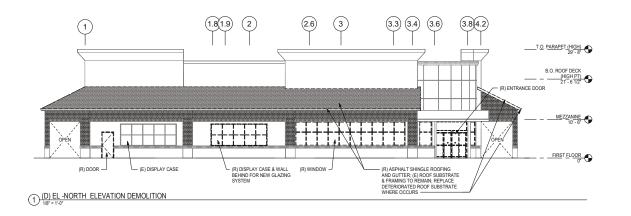

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DEMOLITION ELEVATIONS

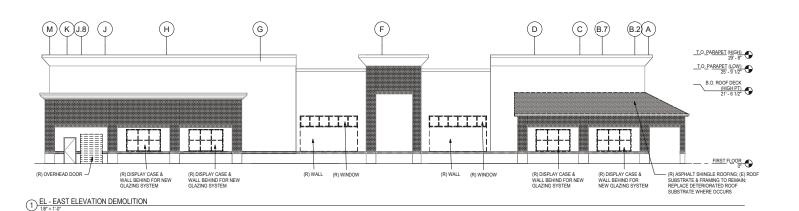- SEE A0.3-0 FOR GENERAL DEMOLITION NOTES
   DEMOLISH ALL CEILINGS AND SOFFITS, U.O.N.







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PROJECT:	22583-0
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SHEET TITLE AND NO. DEMOLITION REFLECTED CEILING PLAN-FIRST FLOOR





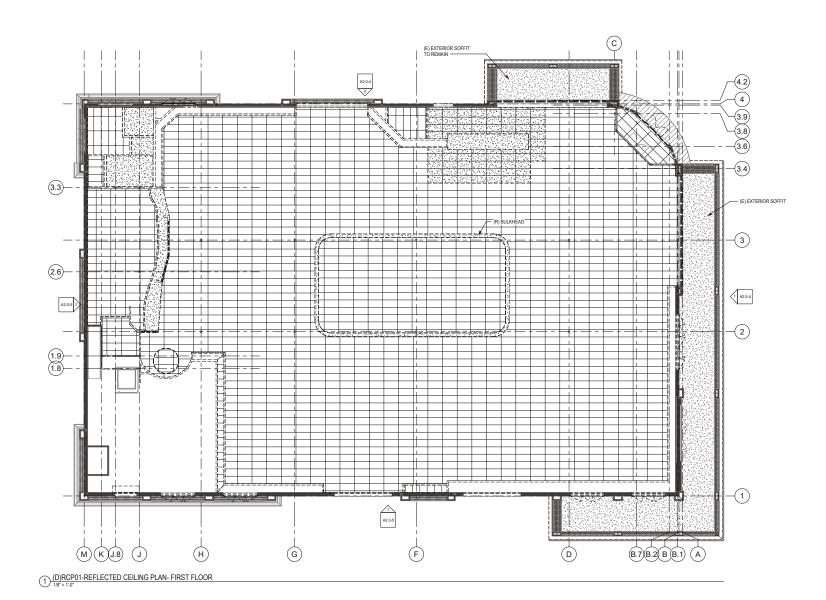
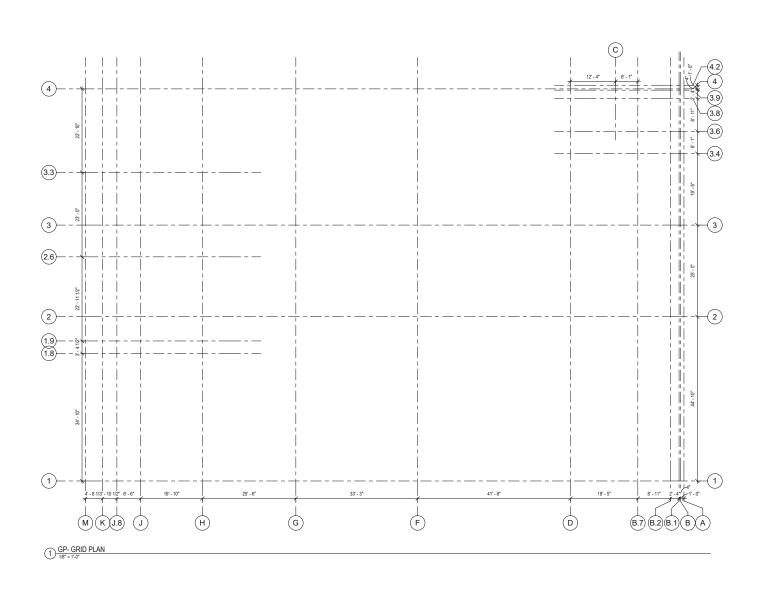
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ISSUE	DATE
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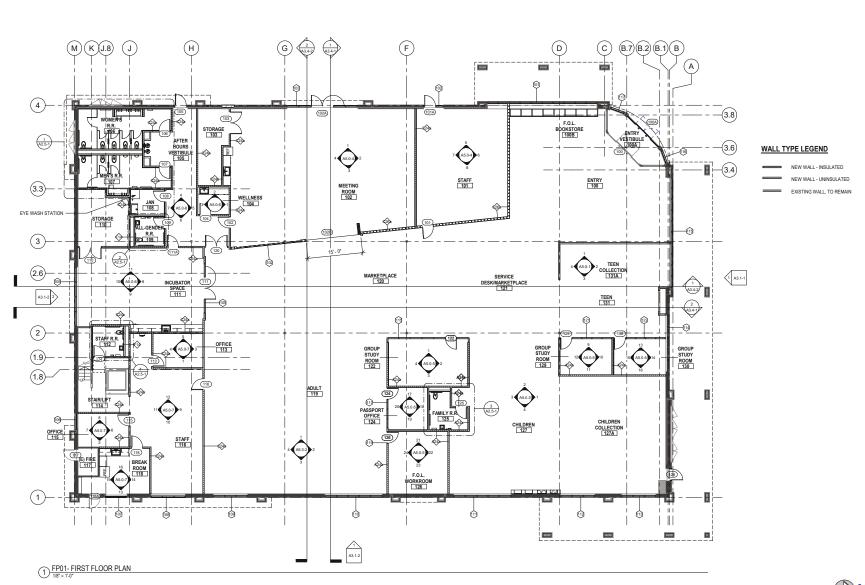


SHEET TITLE AND NO.

GRID PLAN

A2.1-1

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ENTITLEMENT PACKAGE 09/01/2023

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SHEET TITLE AND NO.
FIRST FLOOR PLAN

A2.4-1



## WALL TYPE LEGEND

NEW WALL - INSULATED

NEW WALL - UNINSULATED

EXISTING WALL, TO REMAIN

| I'*D*k

9260 ELK GROVE BLVD ELK GROVE CA 95624


ELK GROVE LIBRARY RETROFIT


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CA REG. —
PROJECT: 22585-02
ISSUE DATE
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SHEET TITLE AND NO.
FLOOR PLAN MEZZANINE

A2.4-2





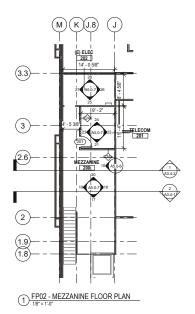
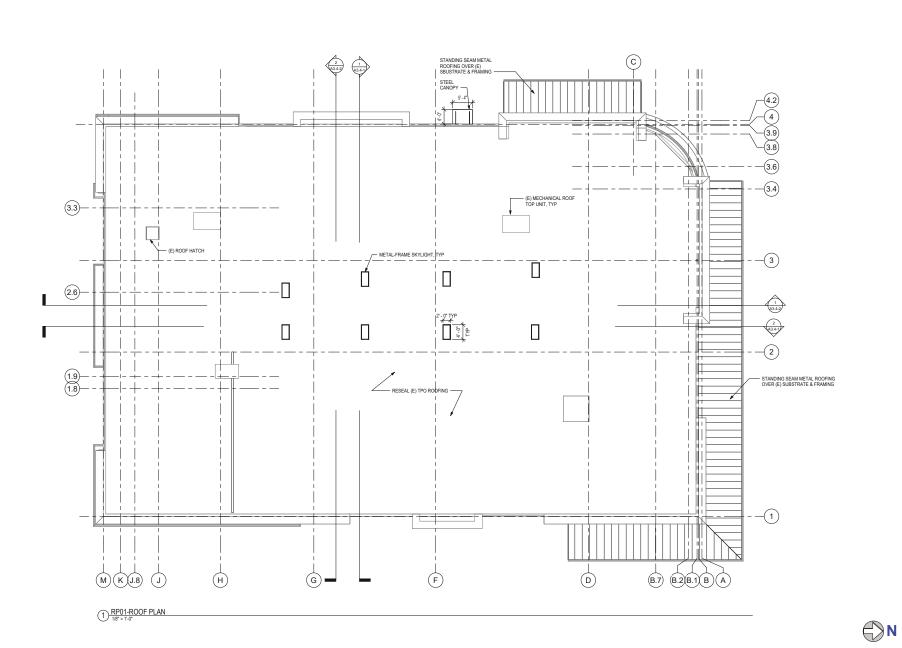
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SHEET TITLE AND NO. ROOF PLAN









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EXTERIOR WALL FINISH LEGEND

P1 DUNN-EDWARDS #DET641

EXISTING CMU

EXISTING TILE

P2 DUNN-EDWARDS #DEC718

P3 DUNN-EDWARDS #DET695

EXISTING BRICK



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SD SUBMITTAL	03/03/202

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SHEET TITLE AND NO.
BUILDING
ELEVATIONS
PRESENTATION

A3.1-3







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SD SUBMITTAL	03/03/202


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SHEET TITLE AND NO.

BUILDING
ELEVATIONS
PRESENTATION

A3.1-4





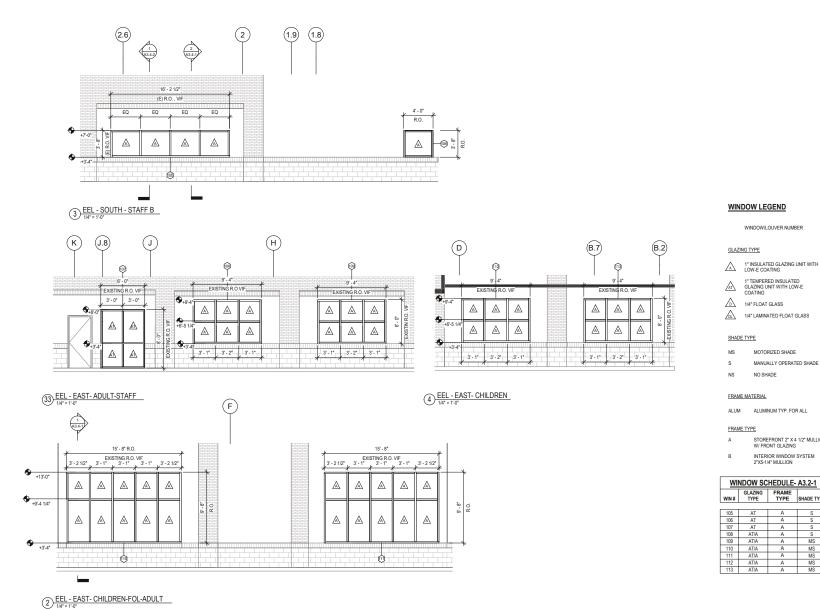

ARCHITECTURE RESEARCH +

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WINDOW/LOUVER NUMBER

MOTORIZED SHADE

MANUALLY OPERATED SHADE NO SHADE

STOREFRONT 2" X 4 1/2" MULLION W/ FRONT GLAZING

S

MS MS MS

INTERIOR WINDOW SYSTEM

2"X5-1/4" MULLION


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CA REG.	-
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ISSUE	DAT
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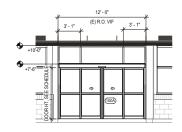
> SHEET TITLE AND NO. **ENLARGED** WINDOW **ELEVATIONS** (EXTERIOR)

A3.2-1




5 EEL - NW - ENTRY STOREFRONT


EQ

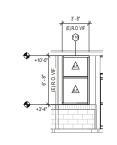


7 EEL - NW - ENTRANCE TRANSOM

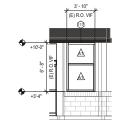


6 EEL - NW - ENTRY STOREFRONT

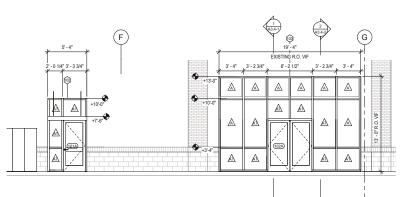

3 EEL - WEST - MEETING ROOM

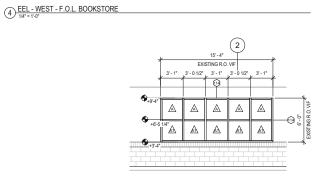

2 EEL - NORTH - CHILDREN

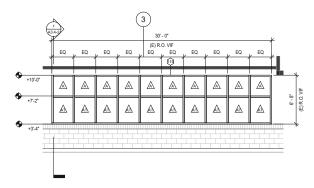

1) EEL - NORTH - TEEN COLLECTION

## WINDOW LEGEND

WINDOW/LOUVER NUMBER

#### GLAZING TYP

1" INSULATED GLAZING UNIT WITH LOW-E COATING

1" TEMPERED INSULATED GLAZING UNIT WITH LOW-E COATING

1/4" FLOAT GLASS

1/4" LAMINATED FLOAT GLASS

#### SHADE TYPE

MS MOTORIZED SHADE

S MANUALLY OPERATED SHADE

NS NO SHADE

#### FRAME MATERIAL

ALUM ALUMINUM TYP. FOR ALL

### FRAME TYPE

A STOREFRONT 2" X 4 1/2" MULLION W/ FRONT GLAZING

W/ FRUNT GLAZING

INTERIOR WINDOW S' 2"X5-1/4" MULLION

WI	NDOW SC	HEDULE-	A3.2-2
WIN#	GLAZING TYPE	FRAME TYPE	SHADE TYPE
101	AT/A	A	MS
102	AT	A	N
103	AT/A	A	MS
114	AT/A	A	MS
115	AT/A	A	MS
116	AT/A	A	N
117	AT/A	A	N

GROUP 4
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CA 9 4 0 8 0 U S A

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ELK GROVE

ELK GROVE

LIBRARY RETROFIT

9260 ELK GROVE

ELK GROVE

CA 95624

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ENLARGED WINDOW ELEVATIONS (EXTERIOR)

A3.2-2

(c)

+10'-0"

+3"-4"

(D)

EQ EQ

30' - 0"


(E) R.O. VIF

EQ


EQ EQ EQ EQ

(i)

 $\triangle$ 

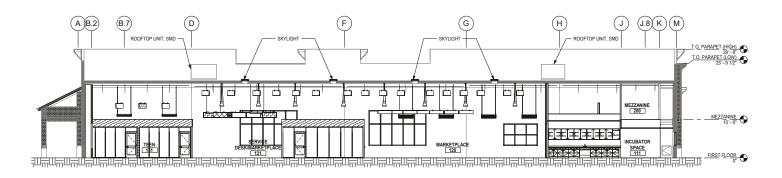

2 BS-BUILDING SECTION @ GRID 2

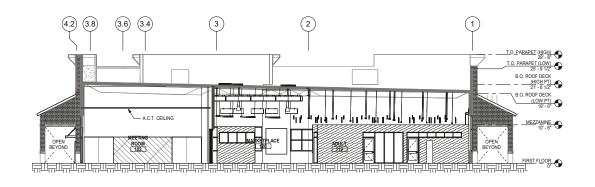

1) BS-BUILDING SECTION @ GRID F






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SHEET TITLE AND NO.
BUILDING
SECTIONS

A3.4-1



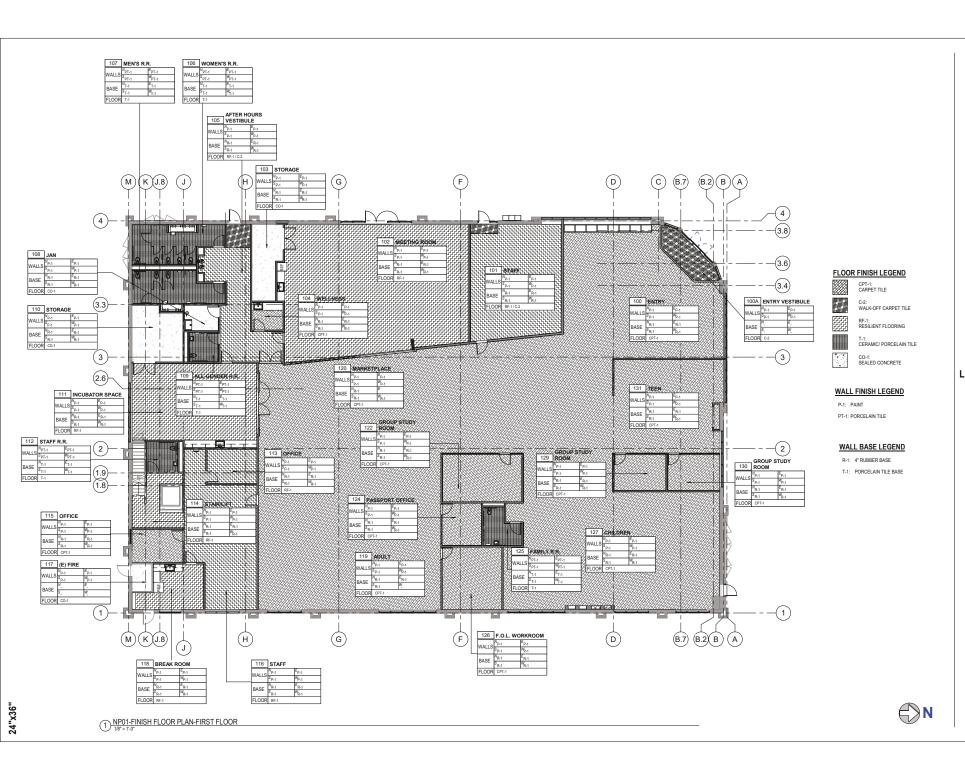

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ELK GROVE

ELK GROVE

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9260 ELK GROVE


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CA 95624


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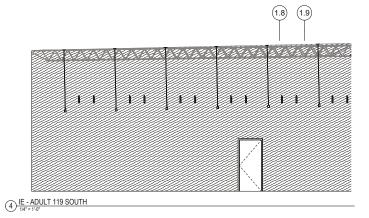
SHEET TITLE AND NO.
FINISH FLOOR
PLAN


A4.1-1






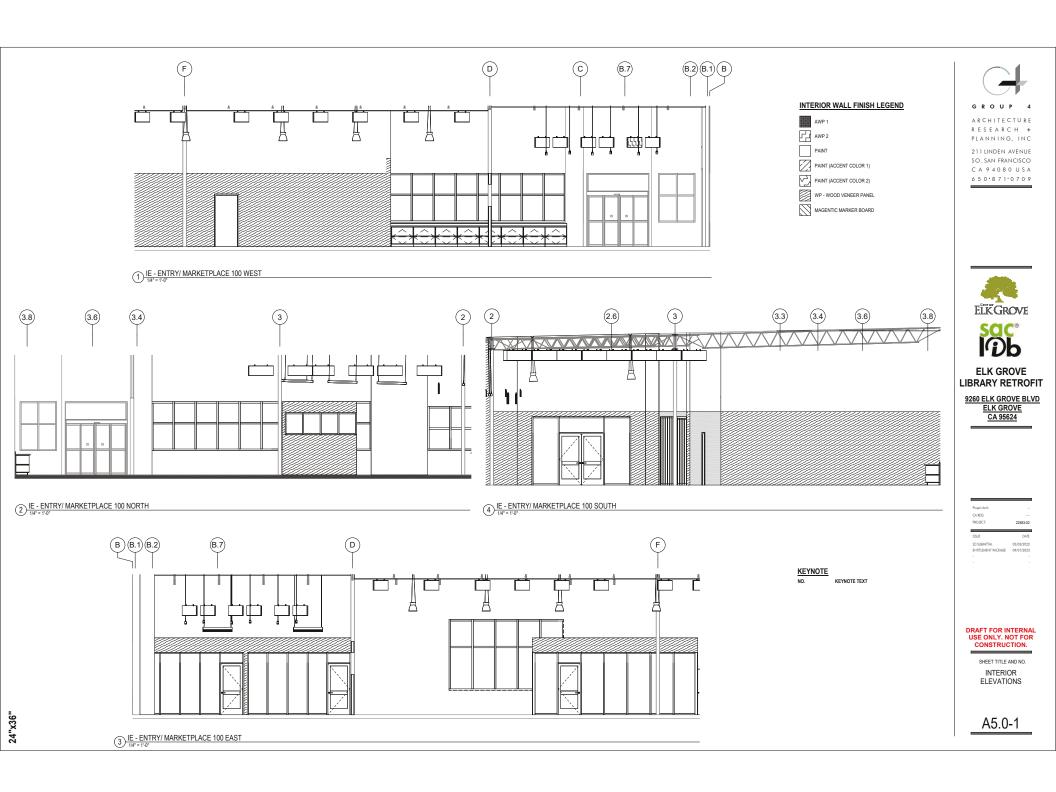

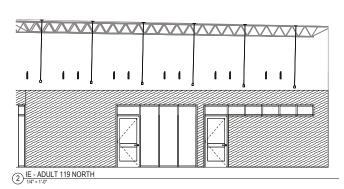

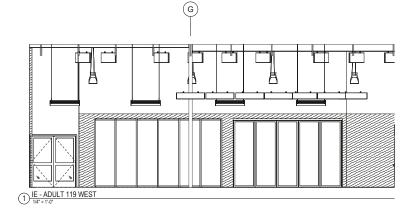

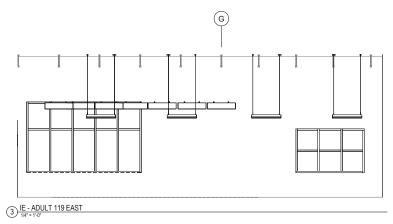



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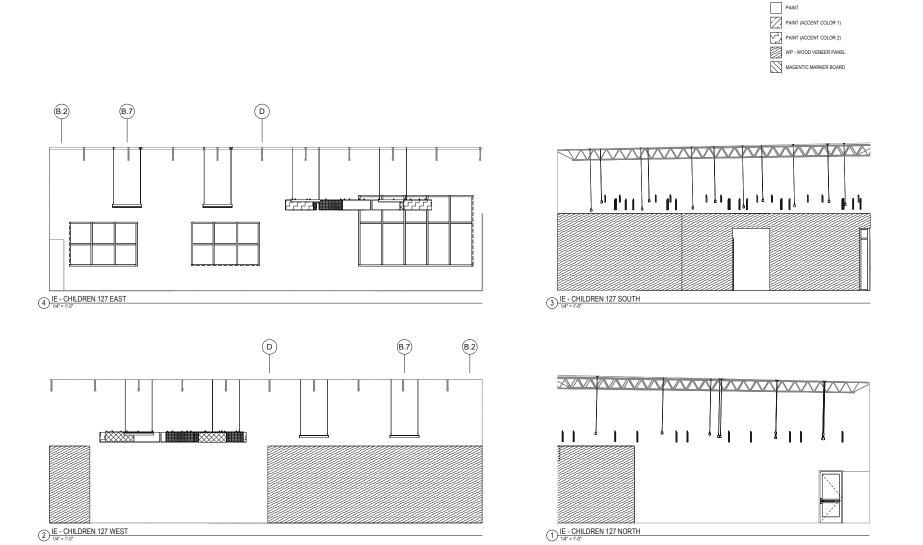


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	03/03/202
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SHEET TITLE AND NO.

INTERIOR
ELEVATIONS



24"x36"



INTERIOR WALL FINISH LEGEND

AWP 1

AWP 2





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	03/03/202	



SHEET TITLE AND NO.

INTERIOR
ELEVATIONS

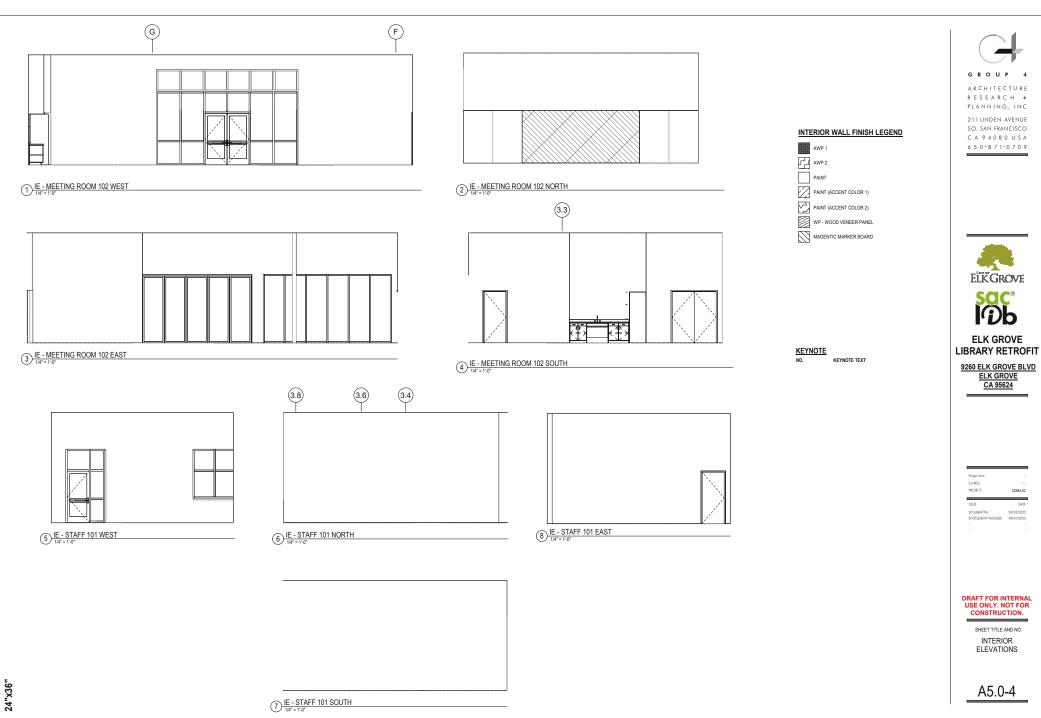

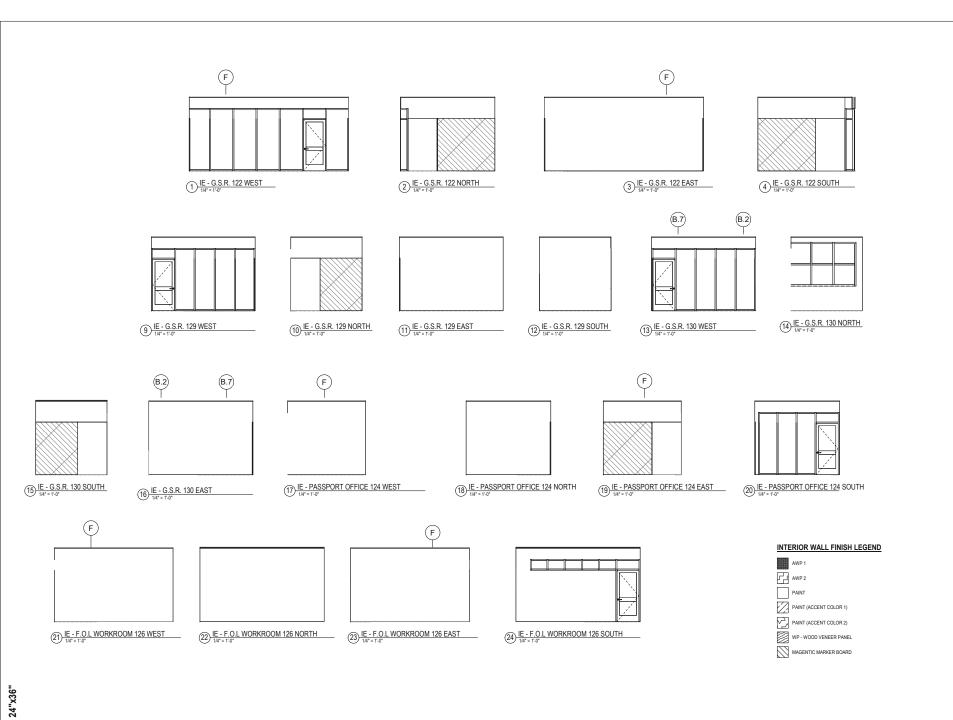






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SHEET TITLE AND NO.

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24"x36"



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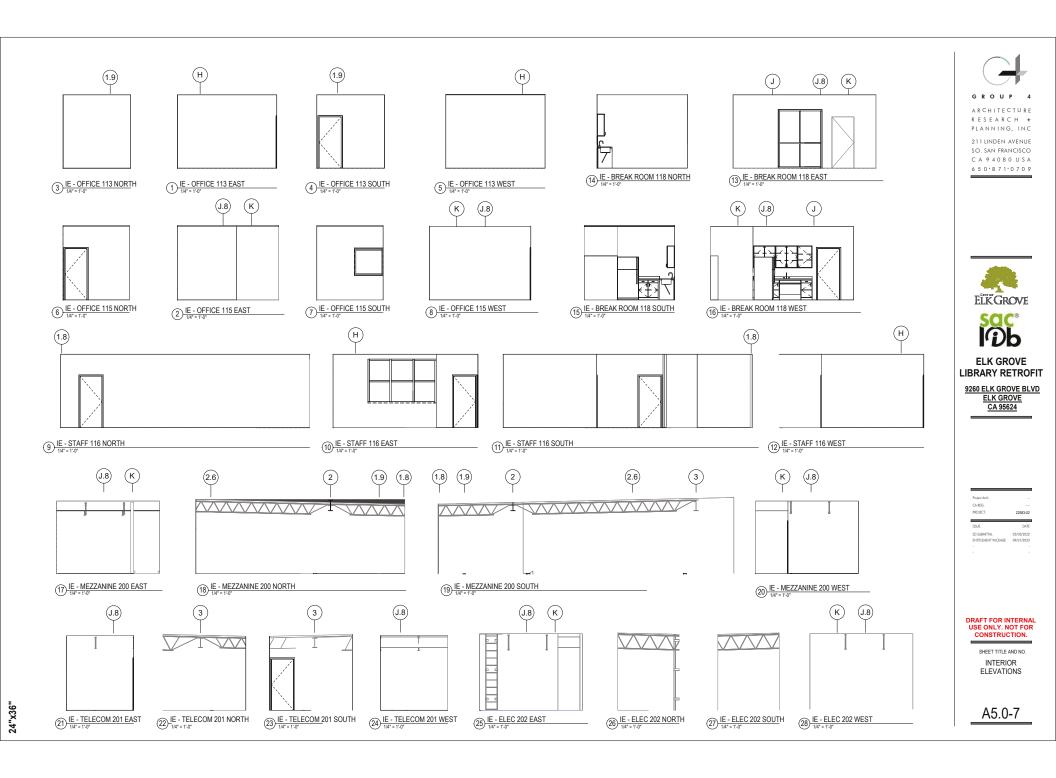

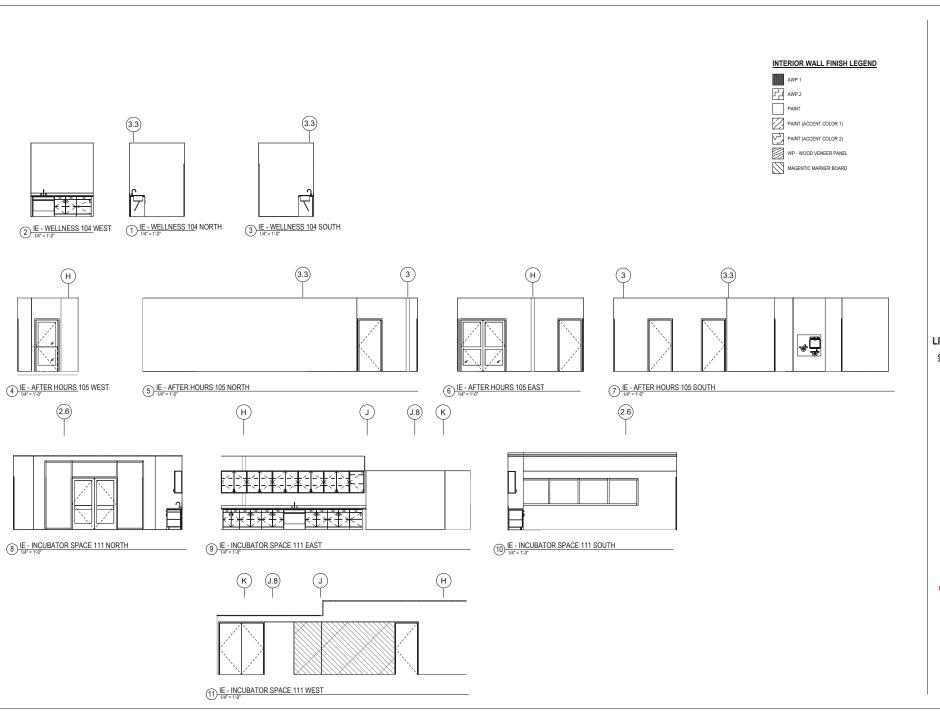
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03/03/2022
09/01/2023

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SHEET TITLE AND NO.

INTERIOR
ELEVATIONS



- ALL NOTES STATED BELOW SHALL APPLY TO AG SERIES ALL ACT CEILING GRID SHALL BE FACTORY MITERED COORDINATE PENETRATIONS IN ROOF WITH STRUCTURAL, MECHANICAL, PLUMBING, CIVIL, ELECTRICAL & TELECOM LIGHTING & MECHANICAL FIXTURES SHOWN FOR COORDINATION, S. M.D., S.E.D. FOR COMPLETE QUANTITY &
- EXTENTS OF FIXTURES.
  ALL EXPOSED BUILDING ELEMENTS SHALL BE PAINTED, U.O.N. EXPOSED IS DEFINED AS VISIBLE, TO ANY EXTENT, WHEN STANDING ON ANY FLOOR, STAIR OR SEATING SURFACE



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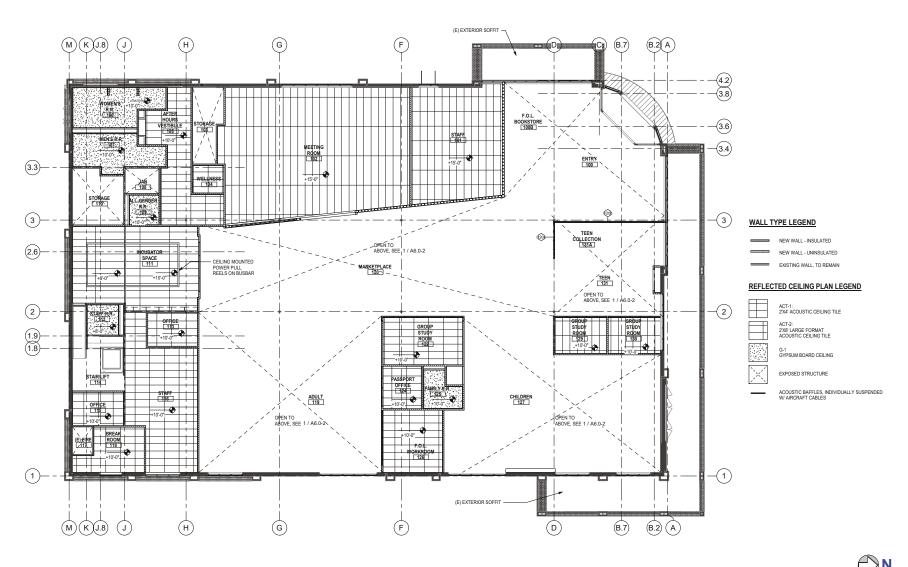


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SHEET TITLE AND NO. REFLECTED CEILING PLAN -FIRST FLOOR LOW

A6.0-1



24"x36"

- ALL NOTES STATED BELOW SHALL APPLY TO A6 SERIES ALL ACT CREINING GRID SHALL BE FACTORY MITERED COORDINATE PERHETATIONS IN DOOF WITH STRUCTURAL, BECKNING, ACCOUNTING THE PERHETATION SHOWN THE TELECOM COORDINATION SHALL SERVICE SHOWN THE STATE OF THE SHALL SHA



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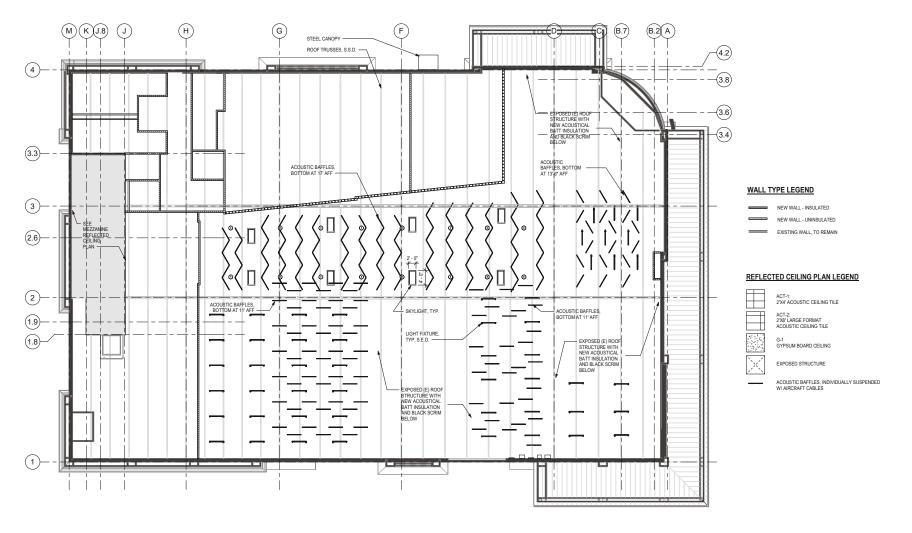


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CA REG.	
PROJECT:	22583-02
ISSUE	DATE
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SHEET TITLE AND NO. REFLECTED CEILING PLAN -FIRST FLOOR HIGH

A6.0-2



- ALL NOTES STATED BELOW SHALL APPLY TO AS SERIES ALL ACT CELING GRID SHALL BE FACTORY MITERED COORDINATE PENETRATIONS IN BOOF WITH STRUCTURAL, MECHANICAL PLUMBING, CIVIL, ELECTRICLA & TELECOM LIGHTING & MECHANICAL FUNDES SHOWN FOR COORDINATION, S.M.D., S.E.D. FOR COMPLETE QUANTITY & EXTENTS OF FIXTURES.
  ALL EXPOSED BUILDING ELEMENTS SHALL BE PAINTED, U.O.N. EXPOSED IS DEFINED AS VISIBLE, TO ANY EXTENT, WHEN STANDING ON ANY FLOOR, STAIR OR SEATING SURFACE



ARCHITECTURE RESEARCH + PLANNING, INC

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# WALL TYPE LEGEND

NEW WALL - INSULATED

NEW WALL - UNINSULATED

EXISTING WALL, TO REMAIN

ACT-1: 2'X4' ACOUSTIC CEILING TILE ACT-2: 2'X8' LARGE FORMAT ACOUSTIC CEILING TILE

EXPOSED STRUCTURE

## REFLECTED CEILING PLAN LEGEND

G-1 GYPSUM BOARD CEILING

ACOUSTIC BAFFLES, INDIVIDUALLY SUSPENDED W/ AIRCRAFT CABLES



**ELK GROVE** 

LIBRARY RETROFIT


9260 ELK GROVE BLVD ELK GROVE CA 95624

CA REG. PROJECT: ISSUE SD SUBMITTAL ENTITLEMENT PACKAGE


DRAFT FOR INTERNAL USE ONLY. NOT FOR CONSTRUCTION.

SHEET TITLE AND NO. REFLECTED CEILING PLAN -MEZZANINE

A6.0-3

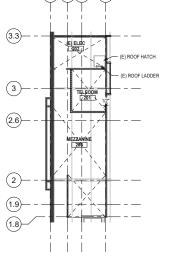

1) RCP02- REFLECTED CEILING PLAN-MEZZANINE

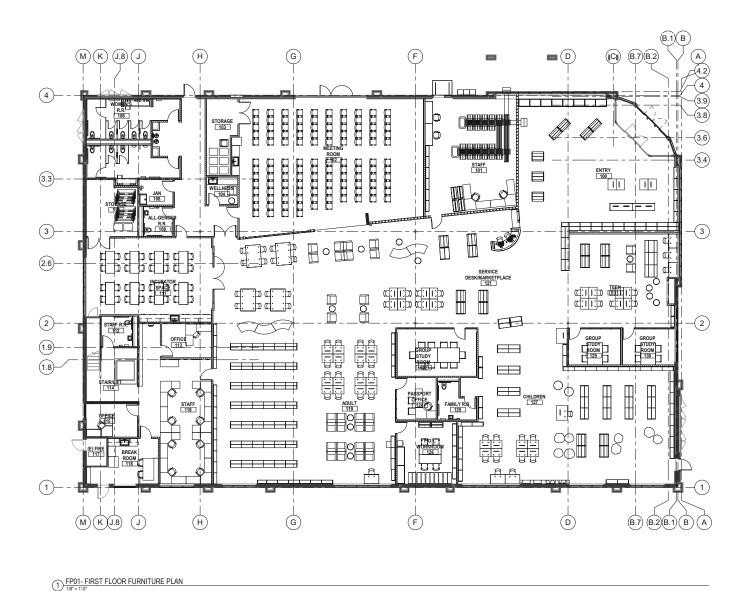



ARCHITECTURE
RESEARCH +
PLANNING, INC
211 LINDEN AVENUE

211 LINDEN AVENUE SO. SAN FRANCISCO C A 9 4 0 8 0 U S A 6 5 0 \* 8 7 1 \* 0 7 0 9



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 PROJECT:
 22588-02

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## DRAFT FOR INTERNAL USE ONLY. NOT FOR CONSTRUCTION.

SHEET TITLE AND NO.
FURNITURE PLANFIRST FLOOR
(N.I.C., FOR
REFERENCE ONLY)

A10.1-1

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## **Exhibit C: Project Conditions of Approval**

	Conditions of Approval	Timing / Implementation	Enforcement / Monitoring	Verification (date <u>and</u> signature)
On-Goi	ng			
1.	Development and operation of the proposed Project shall be consistent with the Project Description and Project Plans as provided in Exhibits A and B, incorporated herein by this reference. Deviations from the approved plans shall be reviewed by the City for substantial compliance and may require amendment by the appropriate hearing body.	On-Going	Planning	
2.	This action does not relieve the Applicant of the obligation to comply with all ordinances, statutes, regulations, and procedures.	On-Going	Planning	
3.	Except as otherwise specified or provided for in the Project plans or in these conditions, the Project shall conform to the development standards and design requirements adopted by the City of Elk Grove, specifically including but not limited to the following:	On-Going	Planning Public Works	
	<ul> <li>The Old Town Special Planning Area</li> <li>The Elk Grove Zoning Code (Title 23 of the EGMC)</li> <li>EGMC Chapter 19.12 (Tree Preservation and Protection)</li> <li>EGMC Chapter 14.10 (Water Efficient Landscape Requirements)</li> </ul>			
4.	The Applicant shall design and construct all improvements in accordance with the City of Elk Grove Improvement Standards, as further conditioned herein, and to the satisfaction of Public Works. All street improvements shall include vertical curb and gutter, except as approved by Public Works, in which case street improvements shall include rolled curb and gutter. Specific locations on median(s) that require emergency vehicle access will be evaluated during review and acceptance of the Improvement Plans.	On-Going	Public Works EGWD SASD SMUD PG&E	
	Public sewer, water, and other utility infrastructure shall be designed and constructed in accordance with the standards of the appropriate utility.			

	Conditions of Approval	Timing / Implementation	Enforcement / Monitoring	Verification (date and signature)
5.	The Applicant shall pay all applicable plan check fees, impact fees, or other costs as required by the City, the Cosumnes Community Services District (CCSD), Sacramento Area Sewer District (SASD), Elk Grove Water District (EGWD), or other agencies or services providers as established by law.	On-Going	Planning Public Works CCSD EGWD SASD	
6.	Approval of this project does not relieve the Applicant from the applicable requirements of subsequent permits and approvals, including but not limited to the following as may be applicable:	On-Going	Planning Public Works Building	
	<ul> <li>Grading Permit and Improvement Plan</li> <li>Building Permit and Certificate of Occupancy</li> <li>Requirements of the Sacramento Metropolitan Air Quality Management District</li> <li>Fire permit</li> </ul>		CCSD EGWD SASD	
7.	Landscaping and tree trimming shall be maintained so that it does not interfere with the operation of surveillance cameras or the lighting of the parking lot, walkways, and outdoor common areas. Trees overhanging the fire lane shall be maintained at 13 feet 6 inches of vertical clearance. Tree trimming shall be completed pursuant to EGMC 19.12 and overseen by a certified arborist.	On-Going	Police CCSD Fire Planning	
8.	Project shall maintain the "easement for future access" (located at the southwest corner of the project site) between parcel 134-0050-0001 and parcel 134-0072-011 for future development of a secondary fire access point for parcel 134-0072-011, when needed.	On-Going	CCSD Fire	
9.	Upon development of parcel 134-0072-011: A Fire Access Agreement between Cosumnes Community Services District and all parcels connected to and served by the fire access easement shall be provided. Fire Access Agreement shall be in a form acceptable to both Applicant and CCSD Fire and recorded with the Sacramento County Recorder.	On-Going	CCSD Fire	

	Conditions of Approval	Timing / Implementation	Enforcement / Monitoring	Verification (date <u>and</u> signature)
10.	Upon development of parcel 134-0072-011: A Fire Access Roadway Maintenance Agreement (RMA) between Cosumnes Community Services District and all parcels connected to and served by the fire access roadway shall be provided. Fire Access Roadway Maintenance Agreement shall in a form acceptable to both Applicant and CCSD Fire and recorded with the Sacramento County Recorder. The roadway maintenance agreement shall include the following: <a href="https://www.cosumnescsd.gov/DocumentCenter/View/24139/CSD-Road-Maintenance-Agreement-Must-be-notarized-PDF">https://www.cosumnescsd.gov/DocumentCenter/View/24139/CSD-Road-Maintenance-Agreement-Must-be-notarized-PDF</a> a. Provisions for the necessary repair and maintenance	On-Going	CCSD Fire	
	<ul> <li>of the roadway surface</li> <li>b. Removal of vegetation overgrowing the roadway and infringing on the roadway clear vertical height of thirteen feet six inches (13'6") or widthof twenty feet (20')</li> <li>c. Provisions for the maintenance, repair, and/or replacement of NO PARKING-FIRE LANE signage or striping</li> <li>d. Provisions for the necessary repair and maintenance of vehicle and pedestrian access gates and opening systems</li> </ul>			
11.	The installation of on-site traffic calming devices such as but not limited to speed bumps, humps or other designs are prohibited unless approved by the fire code official.	On-Going	CCSD Fire	
12.	All fire and life safety systems, including but not be limited to, the fire sprinkler system and fire alarm system, shall be maintained in accordance with California Code of Regulations Title 19. Inspection, testing, and maintenance reports shall be submitted to the Cosumnes Fire Department online reporting system. <a href="https://www.cosumnescsd.gov/1291/Maintaining-Commercial-Fire-Systems">https://www.cosumnescsd.gov/1291/Maintaining-Commercial-Fire-Systems</a>	On-Going	CCSD Fire	

	Conditions of Approval	Timing / Implementation	Enforcement / Monitoring	Verification (date <u>and</u> signature)
13.	SMUD has existing underground 12kV facilities along Elk Grove Blvd, Waterman Road and on the project parcel that will need to remain. The Applicant shall be responsible for maintaining all CalOSHA and State of California Public Utilities Commission General Order No. 128 safety clearances during construction and upon building completion. If the required clearances cannot be maintained, the Applicant shall be responsible for the cost of relocation.	On-Going	SMUD	
Prior To	o or In Conjunction With Improvement and/or Building Permit Submittal	or Approval		
14.	The Planning Division shall be notified immediately if any prehistoric, archaeologic, or paleontologic artifact is uncovered during construction. All construction must stop and an archaeologist that meets the Secretary of the Interior's Professional Qualifications Standards in prehistoric or historical archaeology shall be retained to evaluate the finds and recommend appropriate action.	Improvement Plan	Planning	
	A note stating the above shall be placed on the Improvement Plans.			
15.	All construction must stop if any human remains are uncovered, and the County Coroner must be notified according to Section 7050.5 of California's Health and Safety Code. If the remains are determined to be Native American, the procedures outlined in CEQA Section 15064.5 (d) and (e) shall be followed.	Improvement Plans	Planning	
	A note stating the above shall be placed on the Improvement Plans.			
16.	Any necessary future SMUD facilities located on the Applicant's property shall require a dedicated SMUD easement. This will be determined prior to SMUD performing work on the Applicant's property. A SMUD specific easement will be required for electrical facilities dedicated for car chargers.	Improvement Plans	SMUD	
17.	In the event the Applicant requires the relocation or removal of existing SMUD facilities on the subject property, the Applicant shall coordinate with SMUD. The Applicant shall be responsible for the cost of relocation or removal.	Improvement Plans	SMUD	
18.	SMUD reserves the right to use any portion of its easements on the subject property that it reasonably needs and shall not be responsible for any damages to the developed property within said easement that unreasonably interferes with those needs.	Improvement Plans	SMUD	

	Conditions of Approval	Timing / Implementation	Enforcement / Monitoring	Verification (date <u>and</u> signature)
19.	The Applicant shall not place any building foundations within 5-feet of any SMUD trench to maintain adequate trench integrity. The Applicant shall verify specific clearance requirements for other utilities (e.g., Gas, Telephone, etc.).	Improvement Plans	SMUD	
20.	The Applicant shall comply with SMUD siting requirements (e.g., panel size/location, clearances from SMUD equipment, transformer location, service conductors). Information regarding SMUD siting requirements can be found at: https://www.smud.org/en/Business-Solutions-and-Rebates/Design-and Construction-Services	Improvement Plans	SMUD	
21.	A minimum of 5 bicycle racks shall be provided.	Improvement Plans	Planning	
22.	The Applicant shall install at least one speed bump, or other speed control device, in the parking lot such that drivers are discouraged from using the parking lot as a bypass of the intersection. The quantity, location and design of the speed control device(s) shall be to the satisfaction of the Development Services Director or City Engineer and CCSD Fire.	Improvement Plans	Engineering CCSD Fire	
Prior to	or In Conjunction with Building Permit Submittal or Issuance/Approval			
23.	The Applicant shall prepare and submit for review and approval, prior to Building Permit issuance, a Photometric Study, documenting the nighttime illumination of the site from on-site light fixtures, including both freestanding (e.g., parking lot) and building attached fixtures. The Photometric Study and proposed lighting plan shall comply with the illumination requirements of EGMC Chapter 23.56 (Lighting).	Building Permit	Planning Police	
24.	All seat walls shall be designed and constructed with dividers that prevent loitering.	Building Permit	Planning Police	
25.	To further discourage loiterers, a minimum of two signs shall be posted in the parking lot area that prohibits loitering. These signs shall be in an area where they are clearly visible during nighttime hours, and they shall reference Elk Grove Municipal Code (EGMC) 9.12.010 — Prohibited Loitering.	Building Permit	Police	

	Conditions of Approval	Timing / Implementation	Enforcement / Monitoring	Verification (date <u>and</u> signature)
26.	Final design of the "Library of Things" shed shall be to the satisfaction of the Development Services Director. The shed and immediate surroundings shall be designed to provide natural surveillance and visibility to prevent ambush points and loitering areas. The shed shall be locked at all times when not being accessed to prevent theft. On-site security cameras shall be located to provide monitoring of the shed at all times.	Building Permit	Planning Police	
27.	Final design of the Book Locker and Shelter shall be to the satisfaction of the Development Services Director.	Building Permit	Planning	
28.	The Applicant shall prepare and submit for review and approval, prior to Building Permit issuance, a final Landscape Plan, to the satisfaction of the Development Services Director, that identifies all landscape improvements to be completed.	Building Permit	Planning	
Prior to	Certificate of Occupancy			
29.	Approved radio coverage for emergency responders shall be provided. A test conducted by a licensed contractor shall be performed at building or project completion to determine if the public safety communication system is adequate for emergency responder radio coverage. Buildings that cannot support the required level of radio coverage shall install a distributed antenna system with FCC certified signal boosters subject to Cosumnes Fire Department review and approval.	Certificate of Occupancy	CCSD Fire	

## CERTIFICATION ELK GROVE CITY COUNCIL RESOLUTION NO. 2023-253

STATE OF CALIFORNIA	)	
COUNTY OF SACRAMENTO	)	ss
CITY OF ELK GROVE	)	

I, Jason Lindgren, City Clerk of the City of Elk Grove, California, do hereby certify that the foregoing resolution was duly introduced, approved, and adopted by the City Council of the City of Elk Grove at a regular meeting of said Council held on October 25, 2023 by the following vote:

AYES: COUNCILMEMBERS: Singh-Allen, Spease, Brewer, Robles, Suen

NOES: COUNCILMEMBERS: None

ABSTAIN: COUNCILMEMBERS: None

ABSENT: COUNCILMEMBERS: None

Vason Lindgren, City Clerk
City of Elk Grove, California